

WASHINGTON NORTH - SITE 1

**6 Mountain Road
Washington, Connecticut**

Description of Proposed Cell Site

Cellco Partnership d/b/a Verizon Wireless
99 East River Drive
East Hartford, CT 06108

TABLE OF CONTENTS

<u>SECTION</u>	<u>PAGE</u>
GENERAL CELL SITE DESCRIPTION	1
U.S.G.S. TOPOGRAPHIC MAP	2
AERIAL PHOTOGRAPH	3
SITE EVALUATION REPORT	4
FACILITIES AND EQUIPMENT SPECIFICATION.....	6
ENVIRONMENTAL ASSESSMENT STATEMENT.....	7
PROJECT PLANS.....	9

SITE NAME: WASHINGTON NORTH (SITE 1) – 6 Mountain Road, Washington, CT

GENERAL CELL SITE DESCRIPTION

The proposed cell site would be located within an 80' x 120' leased area in the northerly portion of an approximately 32.07-acre parcel ("Property") owned by H. Ray and Carol A. Underwood at 6 Mountain Road in Washington (the "Site 1 Facility"). The Site 1 Facility would consist of a 150-foot telecommunications tower disguised as a pine tree. Simulated branches will extend an additional seven (7) feet above the top of the tower to an overall height of 157 feet. Cellco antennas would be mounted at the top of the tower with their centerline at the 150 foot level. Cellco's radio equipment and a back-up generator will be located inside a 12' x 30' equipment shelter located near the base of the tower. Vehicle access to the site would extend from Mountain Road over an existing driveway on the property at 16 Mountain Road, then over a new 12-foot wide gravel driveway, a total distance of approximately 1,065 feet, to the site compound. A significant portion of the new gravel access driveway will follow an existing dirt driveway on the Property. Utility service would extend underground from Mountain Road along the proposed access driveway to the cell site.



Source: Kent and New Preston Connecticut USGS 7.5 Minute Topographic Quadrangle Maps



Quadrangle Location

Vanasse Hangen Brustlin, Inc.

USGS Topographic Map
Proposed Verizon Wireless
Telecommunications Facility

Two Alternative Site Locations
Site 1 - 6 Mountain Road
Washington, Connecticut
Site 2 - 167 New Milford Turnpike
New Preston, Connecticut





Source: 2005 Digital Aerial Photograph



Quadrangle Location

* Note: Alternative sites are located approximately 0.46 mile apart

Vanasse Hangen Brustlin, Inc.

Aerial Photograph
Proposed Verizon Wireless
Telecommunications Facility

Two Alternative Site Locations
Site 1 - 6 Mountain Road
Washington, Connecticut
Site 2 - 167 New Milford Turnpike
New Preston, Connecticut



SITE EVALUATION REPORT

SITE NAME: WASHINGTON NORTH (SITE 1) – 6 Mountain Road, Washington, CT

I. LOCATION

- A. COORDINATES: 41°-40'-8.93" N 73°-21'-55.02" W
- B. GROUND ELEVATION: Approximately 693± feet AMSL
- C. USGS MAP: New Preston, CT
- D. SITE ADDRESS: 6 Mountain Road, Washington, CT
- E. ZONING WITHIN 1/4 MILE OF SITE: Land within 1/4 mile of the cell site is zoned R-1 Residential and B-3 Marble Dale Business.

II. DESCRIPTION

- A. SITE SIZE: 80' x 120' Leased Compound Area
- B. LESSOR'S PARCEL: Approximately 32.07-acres
- C. TOWER TYPE/HEIGHT: 150' Monopine Tower
153' to top of PCS antennas
157' to top of Simulated Branches
- D. SITE TOPOGRAPHY AND SURFACE: The topography in the area is fairly severe and slopes down from northwest to southeast, through the Underwood Property toward Route 202. Clearing and grading of the leased area and access driveway will be required. The site has been situated so as to minimize, to the extent possible, the clearing of substantial trees.
- E. SURROUNDING TERRAIN, VEGETATION, WETLANDS, OR WATER: The tower is located in a heavily-wooded portion of the Underwood Property. The terrain around the tower site slopes down from northwest to southeast toward Route 202. No wetland areas exist within or near the site compound or the access driveway. The closest wetland or watercourse is a man-made pond located approximately 440 feet south of the Site 1 Facility compound.
- F. LAND USE WITHIN 1/4 MILE OF SITE: The Site 1 Facility is surrounded by undeveloped and agricultural land and low density residential development.

III. FACILITIES

- A. POWER COMPANY: Connecticut Light and Power
- B. POWER PROXIMITY TO SITE: Approximately 1,065 feet to the southwest.
- C. TELEPHONE COMPANY: AT&T
- D. PHONE SERVICE PROXIMITY: Same as power
- E. VEHICLE ACCESS TO SITE: Vehicle access to the site would extend from Mountain Road over a portion of the landowner's existing driveway on the property located at 16 Mountain Road, then over a new 12-foot wide gravel driveway to the site compound a total distance of approximately 1,065 feet. A significant portion of the new gravel access drive will follow an existing dirt driveway on the Underwood Property.
- F. CLEARING AND FILL REQUIRED: Clearing and grading would be required for construction of the tower, site compound and new access drive. Detailed construction plans would be developed after approval of the site by the Siting Council.

IV. LEGAL

- A. PURCHASE [] LEASE [X]
- B. OWNER: H. Ray and Carol A. Underwood
- C. ADDRESS: 6 Mountain Road, New Preston, CT 06777
- D. DEED ON FILE AT: Town of Washington, CT Land Records

Vol. 131 Page 447

ENVIRONMENTAL ASSESSMENT STATEMENT

SITE NAME: WASHINGTON NORTH (SITE 1) – 6 Mountain Road, Washington, CT

I. PHYSICAL IMPACT

A. WATER FLOW AND QUALITY

No water flow and/or water quality changes are anticipated as a result of the construction or operation of the facility. There are no lakes, ponds, rivers, streams, wetlands or other regulated bodies of water located in the area to be used for the access drive, tower or equipment building. The equipment used will not discharge any pollutants to area surface or groundwater systems.

B. AIR QUALITY

Under ordinary operating conditions, the equipment that would be used at the site would emit no air pollutants of any kind. For limited periods during power outages and periodically for maintenance purposes, minor levels of emissions from the on-site generator would result.

Pursuant to R.C.S.A. § 22a-174-3, the on-site emergency back-up generator proposed as a part of this application would require the issuance of a Connecticut Department of Environmental Protection Air Bureau permit for potential emissions. Cellco would obtain this permit prior to installing the generator at the approved cell site.

C. LAND

Clearing and grading of the tower compound and access drive will be required. The remaining land of the Lessor would remain unchanged by the construction and operation of the cell site.

D. NOISE

The equipment to be in operation at the site after construction would emit no noise of any kind, except for operation of the installed heating, air conditioning and ventilation systems and occasional operation of a back-up generator which would be run during power failures and periodically for maintenance purposes. Some noise is anticipated during cell site construction, which is expected to take approximately four to six weeks.

E. POWER DENSITY

The worst-case calculation of power density for Cellco's PCS antennas at the Washington North facility would be 2.46% of the Standard.

F. VISIBILITY

See Visual Resource Evaluation Report included as Attachment 10.

Cellco Partnership

d.b.a. **verizon** wireless

WIRELESS COMMUNICATIONS FACILITY


WASHINGTON NORTH

77 SITE 1⁷⁷

MOUNTAIN ROAD

NEW PRESTON, CT

NO.	DATE	DESCRIPTION
00	10/22/06	SITING COUNCIL REVIEW
01	01/09/07	CT SITING COUNCIL
02	02/27/07	REVISED CT SITING COUNCIL
03	03/22/07	REVISED CT SITING COUNCIL

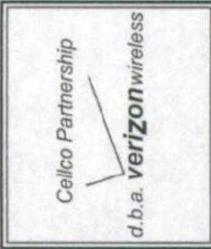

WASHINGTON NORTH
(UNDERWOOD PROPERTY)
'SITE 1'
MOUNTAIN ROAD
NEW PRESTON, CT 06777

PROJECT NO:	06068
DRAWN BY:	DMD
CHECKED BY:	CFC
SCALE:	AS NOTED
DATE:	06/19/06

TITLE SHEET

T-1
DWG. 1 OF 8

PROJECT SUMMARY

SITE NAME: WASHINGTON NORTH
SITE ADDRESS: MOUNTAIN ROAD
 NEW PRESTON, CT 06777

PROPERTY OWNER: H. RAY & CAROL A. UNDERWOOD
 P.O. BOX 2427
 NEW PRESTON, CT 06777

LEASOR: H. RAY & CAROL A. UNDERWOOD
 P.O. BOX 2427
 NEW PRESTON, CT 06777

LESSEE: CELCO PARTNERSHIP
 d.b.a. VERIZON WIRELESS
 99 EAST RIVER DRIVE
 EAST HARTFORD, CT 06108

APPLICANT: CELCO PARTNERSHIP
 d.b.a. VERIZON WIRELESS
 99 EAST RIVER DRIVE
 EAST HARTFORD, CT 06108

CONTACT PERSON: SANDY CARTER
 CELCO PARTNERSHIP
 (860) 803-8219


TOWER COORDINATES: LATITUDE: 41°16'08.898"
 LONGITUDE: 72°52'56.07"
 GND ELEVATION: 883.4 A.M.S.L.
 COORDINATES ARE BASED ON FAA 2C CERTIFICATION
 CONDUCTED BY MARTINEZ COUCH AND ASSOCIATES LLC,
 DATED NOVEMBER 6, 2006.

LEGEND

SYMBOL	DESCRIPTION
(Symbol with 'S')	SECTION OR DETAIL NUMBER SHEET WHERE DETAIL/SECTION OCCURS
(Symbol with 'E')	ELEVATION NUMBER SHEET WHERE ELEVATION OCCURS

SHEET INDEX

SHEET NO.	DESCRIPTION	REV. NO.
T-1	TITLE SHEET	03
C-1	SITE PLAN AND ABUTTERS MAP	03
C-2	PARTIAL SITE PLAN	03
C-2A	COMPOUND ELEVATIONS (TOWER OPTIONS)	03
C-3	EROSION CONTROL DETAILS AND NOTES	03
C-4	SITE DETAILS	03
C-5	SITE UTILITY DETAILS AND SHELTER ELEVATIONS	03
C-6	EQUIP. SHELTER FOUNDATION DETAILS AND NOTES	03

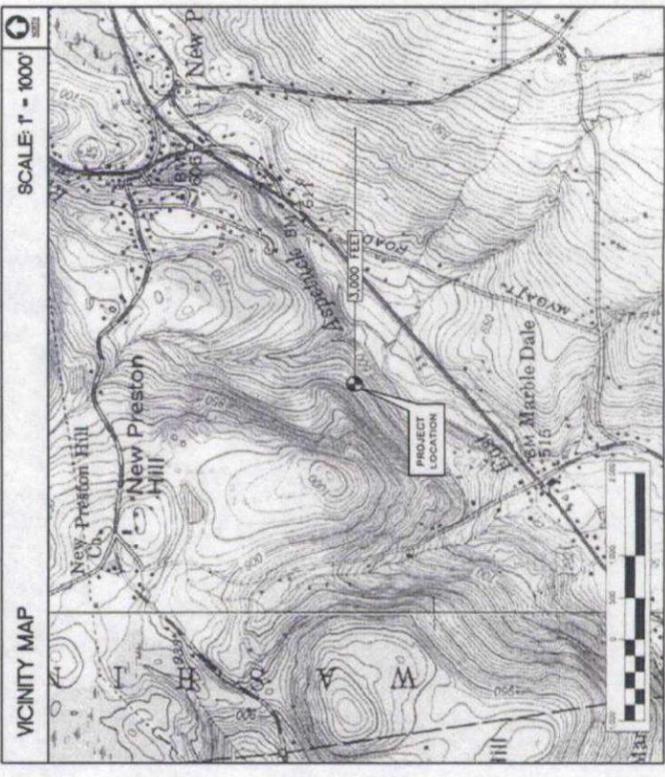

SITE DIRECTIONS

FROM: 99 EAST RIVER DRIVE, EAST HARTFORD, CONNECTICUT **TO:** MOUNTAIN ROAD, NEW PRESTON, CONNECTICUT

-START OUT GOING EAST ON EAST RIVER DRIVE TOWARD DARLIN ST.
 -TURN LEFT TO STAY ON EAST RIVER DRIVE
 -TURN LEFT ONTO US-44 W/CONNECTICUT BLVD.
 -TURN LEFT ONTO US-6 W/US-44 W.
 -MERGE ONTO I-84 W/US-6.
 -MERGE ONTO CT-4 W/FARMINGTON AVE VIA EXIT 39 TOWARD FARMINGTON.
 -TURN SLIGHT RIGHT ONTO MAIN STREET / CT-4, CONTINUE TO FOLLOW CT-4.
 -TURN LEFT ONTO SPELMAN / CT-4, CONTINUE TO FOLLOW CT-4.
 -CT-4 BECOMES CT-118 / EAST STREET.
 -TURN LEFT ONTO CT-118 / EAST STREET.
 -TURN LEFT ONTO CT-118 / EAST STREET.
 -KEEP RIGHT AT FORK TO CONTINUE ON EAST STREET/CT-118
 -STAY STRAIGHT TO GO ONTO WEST STREET/US-202. CONTINUE ON US-202.
 -TURN SLIGHT RIGHT ONTO US-202/BANTAM RD. CONTINUE ON US-202.
 -TURN LEFT ONTO US-202/LITCHFIELD TRPK/WILBUR RD. CONTINUE ON US-202.
 -TURN RIGHT ONTO FINLEY ROAD.
 -TURN RIGHT ONTO MOUNTAIN ROAD.

GENERAL NOTES

1. PROPOSED ANTENNA LOCATIONS AND HEIGHTS PROVIDED BY CELCO PARTNERSHIP.

SITE INFORMATION


THE SCOPE OF WORK SHALL INCLUDE:

1. THE CONSTRUCTION OF A 35'x65' FENCED WIRELESS COMMUNICATIONS COMPOUND WITHIN A 80'x120' LEASE AREA.
2. SITE GRADING WILL BE REQUIRED WITHIN LEASE AREA AND ACCESS DRIVE FOR PROPER DRAINAGE. A TOTAL OF TWENTY-FOUR TREES WILL BE REQUIRED TO BE REMOVED TO ACCOMMODATE THE PROPOSED COMPOUND AND ACCESS DRIVE.
3. A TOTAL OF TWELVE (12) DIRECTIONAL PANEL ANTENNAS ARE PROPOSED TO BE MOUNTED AT A RAD CENTER ELEVATION OF 150'-0" +/- AGL ON A 157' MONOPOLE (OR OPTIONAL 150' MONOPOLE) TOWER LOCATED CENTRALLY WITHIN THE PROPOSED COMPOUND.
4. POWER AND TELCO UTILITIES SHALL BE ROUTED UNDERGROUND FROM EXISTING RESPECTIVE DEMARKS TO THE PROPOSED UTILITY BACKBOARD LOCATED ADJACENT TO THE PROPOSED FENCED COMPOUND. UTILITIES WILL BE ROUTED FROM UTILITY BACKBOARD TO THE PROPOSED COMPOUND. FINAL UTILITY ROUTING TO PROPOSED BACKBOARD WILL BE VERIFIED/DETERMINED BY LOCAL UTILITY COMPANIES.
5. FINAL DESIGN FOR TOWER AND ANTENNA MOUNTS SHALL BE INCLUDED IN THE FINAL CONSTRUCTION DOCUMENTS.
6. THE PROPOSED WIRELESS FACILITY INSTALLATION WILL BE DESIGNED IN ACCORDANCE WITH THE 2003 INTERNATIONAL BUILDING CODE AS MODIFIED BY THE 2005 CONNECTICUT SUPPLEMENT.
7. THERE WILL NOT BE ANY LIGHTING UNLESS REQUIRED BY THE FCC OR THE FAA.
8. THERE WILL NOT BE ANY SIGNS OR ADVERTISING ON THE ANTENNAS OR EQUIPMENT.
9. FOR ADDITIONAL NOTES AND DETAILS REFER TO THE ACCOMPANYING DRAWINGS.

REVISIONS	
00	10/27/06 SITTING COUNCIL REVIEW
01	01/09/07 CT SITTING COUNCIL
02	02/27/07 REVISED CT SITTING COUNCIL
03	03/22/07 REVISED CT SITTING COUNCIL

Cellco Partnership
d.b.a. verizon wireless

Natcomm, LLC - Engineering Consultants
Natcomm, LLC - Engineering Consultants
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www.natcomm.com
Consulting Engineers, Project Management
and Structural Mechanical Engineer

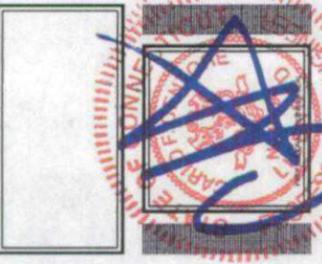


WASHINGTON NORTH
(UNDERWOOD PROPERTY)
"SITE 1"
MOUNTAIN ROAD
NEW PRESTON, CT 06777


PROJECT NO: 06088
DRAWN BY: DMD
CHECKED BY: CFC
SCALE: AS NOTED
DATE: 08/19/06

SITE PLAN
AND
ABUTTERS MAP


C-1
DWG. 2 OF 8

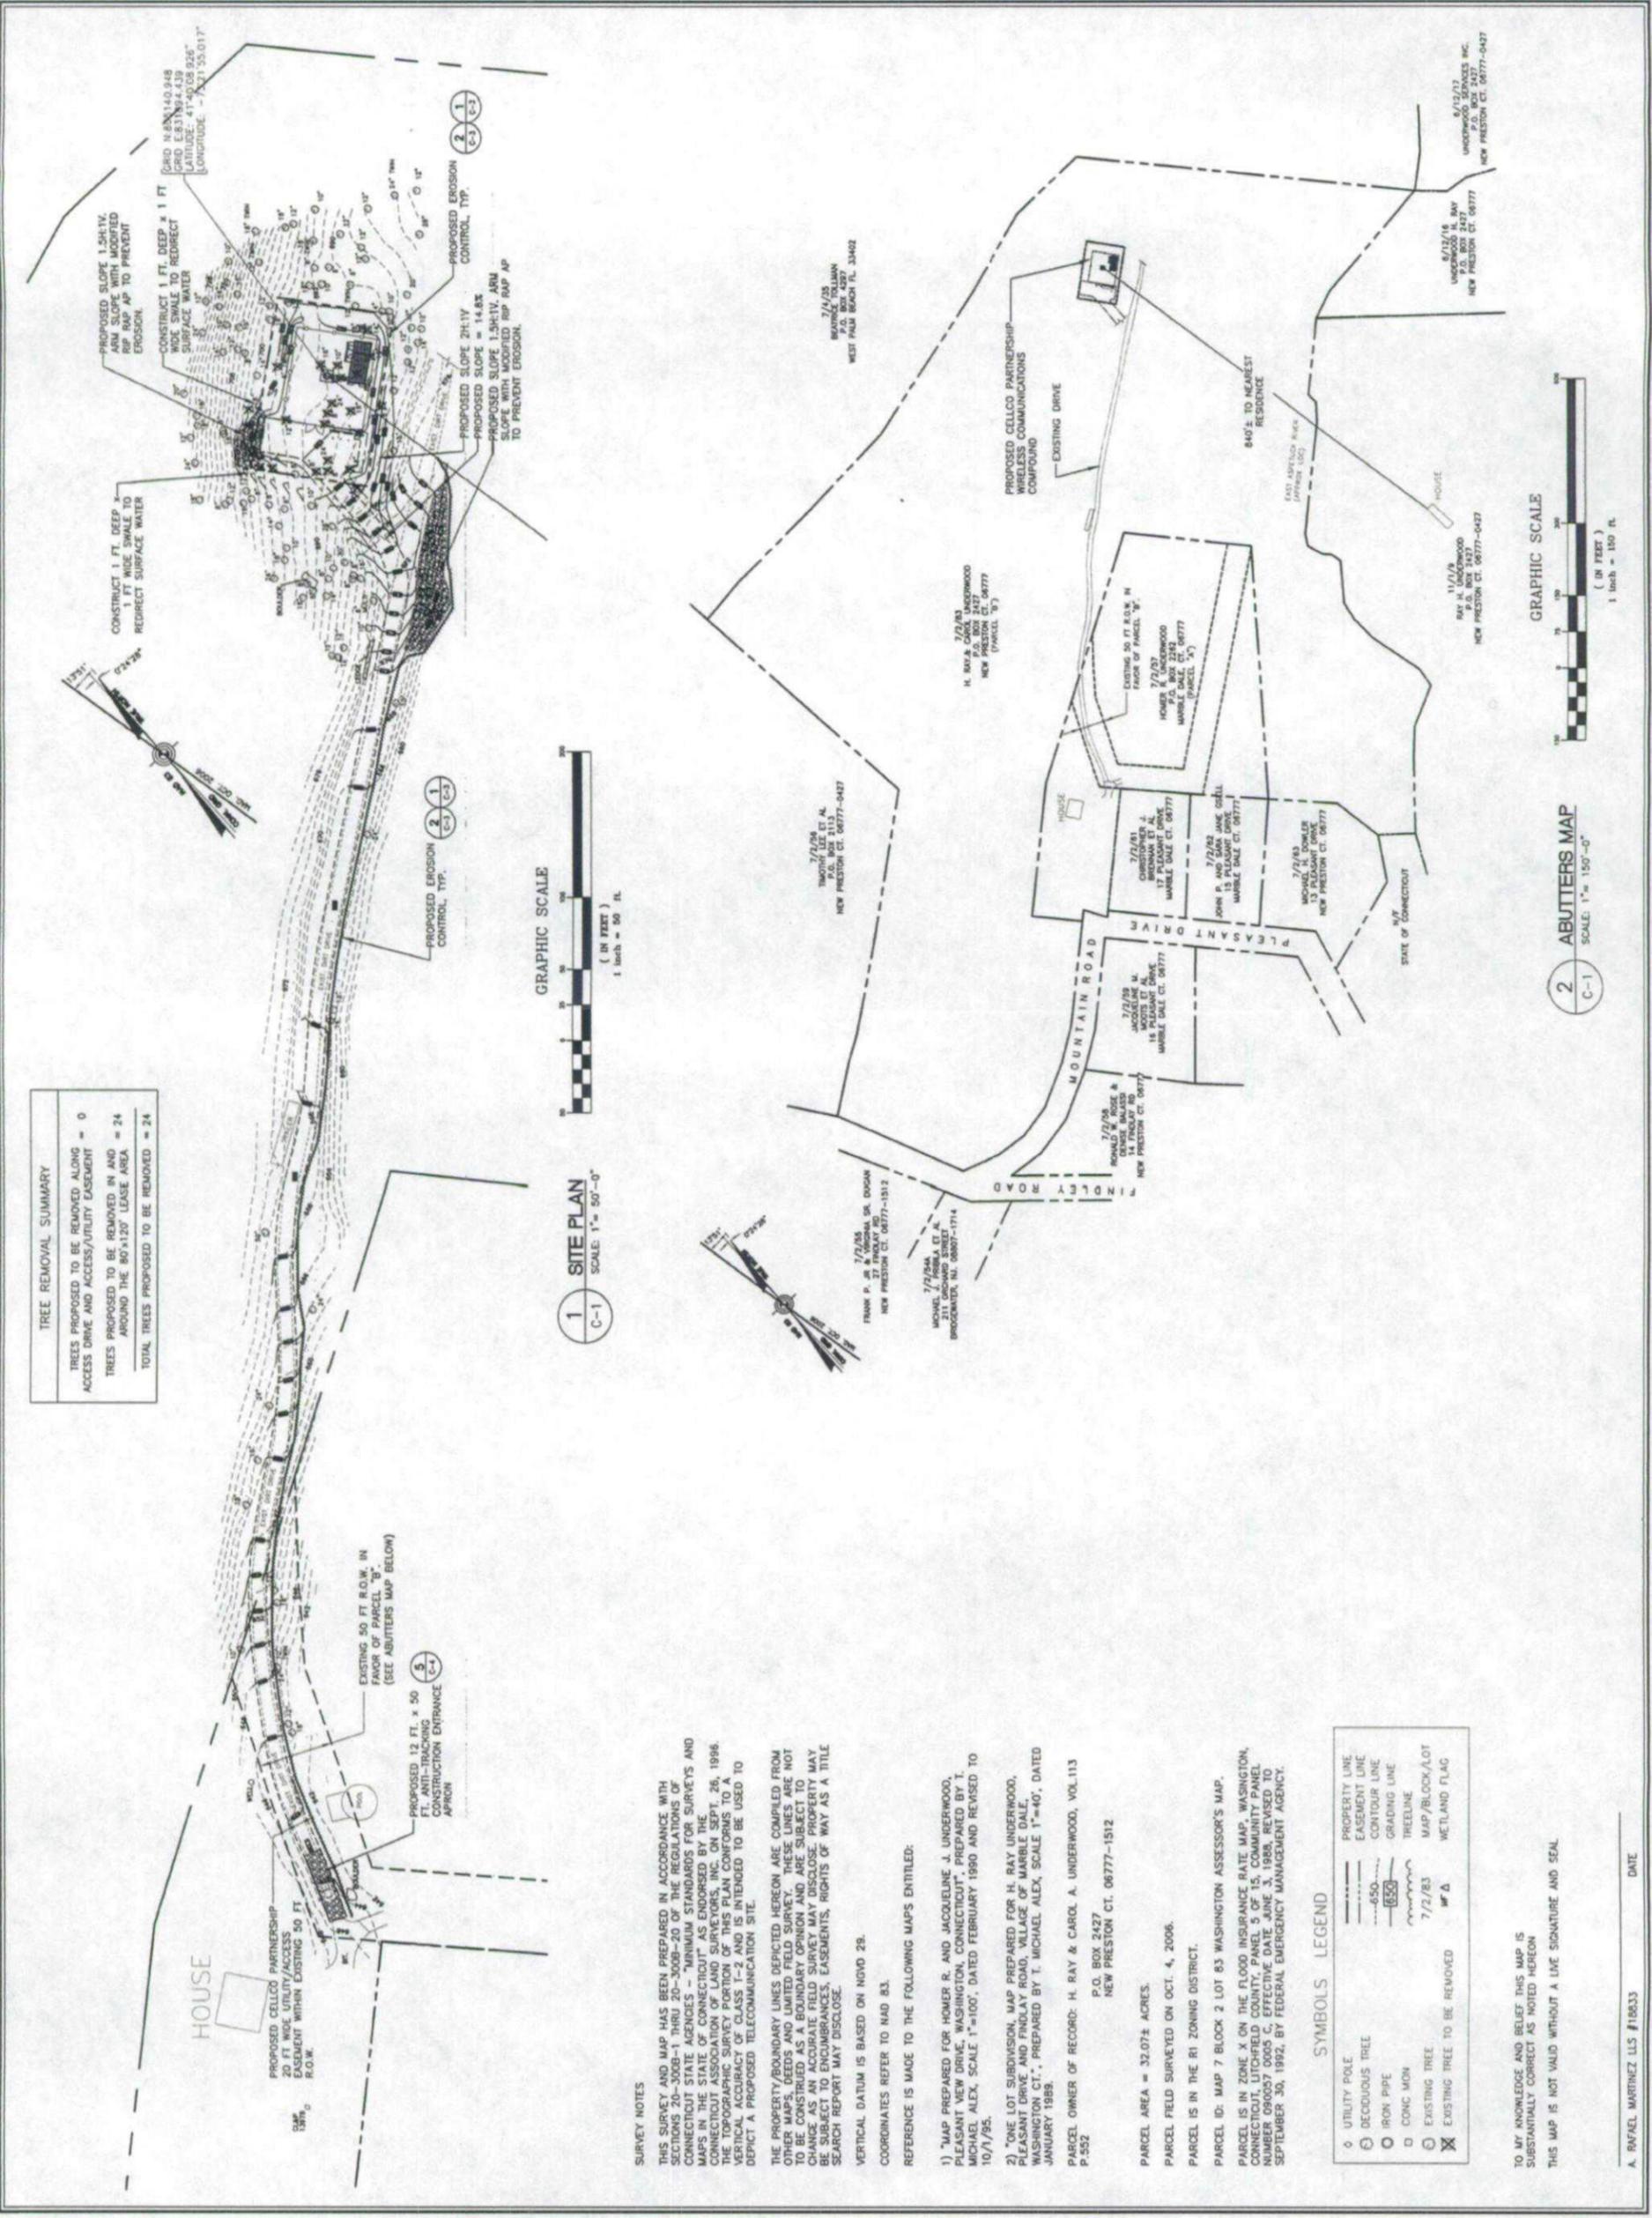

REVISIONS	
00	19/2/06 SITING COUNCIL REVIEW
01	01/05/07 CT SITING COUNCIL
02	02/21/07 REVISED CT SITING COUNCIL
03	03/22/07 REVISED CT SITING COUNCIL

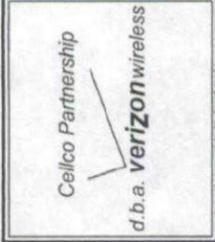

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 ■ Natcom, LLC - Engineering Consultants
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 Consulting Engineers, Project Managers
 Civil, Structural, Mechanical, Electrical

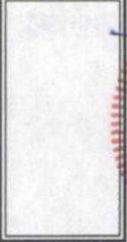


WASHINGTON NORTH
 (UNDERWOOD PROPERTY)
"SITE 1"
 MOUNTAIN ROAD
 NEW PRESTON, CT 06877

PROJECT NO:	06068
DRAWN BY:	DMD
CHECKED BY:	CFC
SCALE:	AS NOTED
DATE:	06/19/06

**PARTIAL
 SITE PLAN**

C-2
 DWG. 3 OF 8

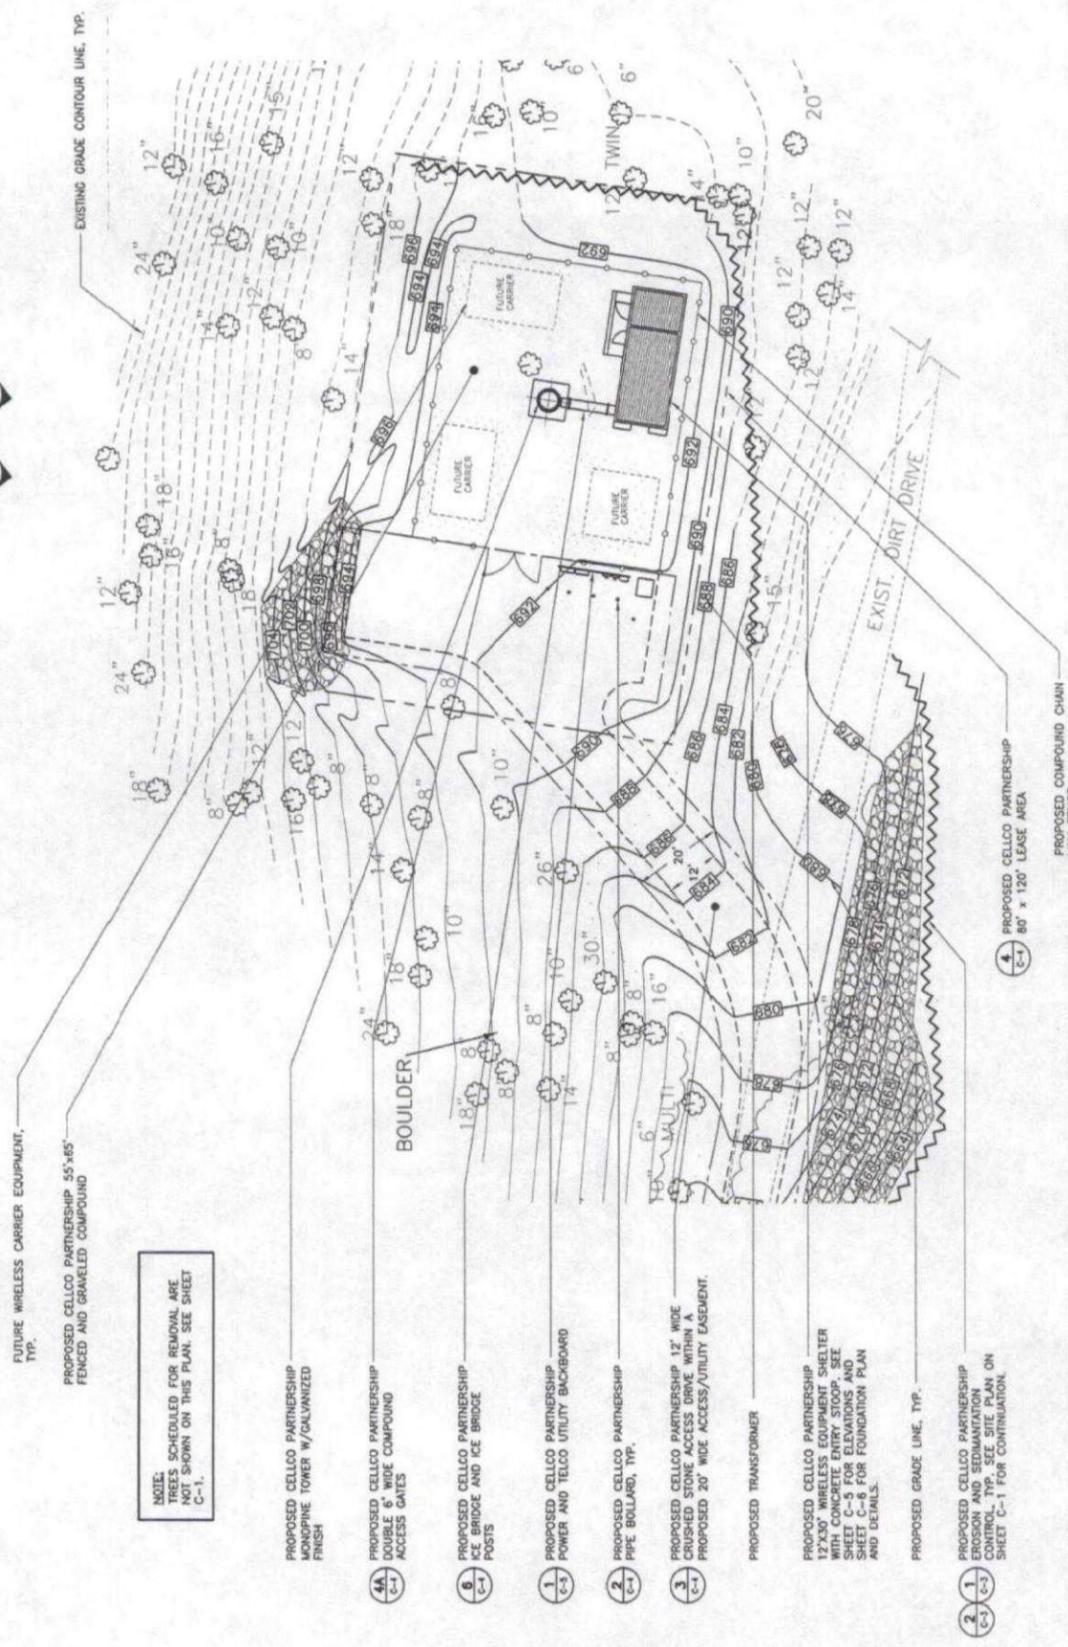

NOTE:
 TREES SCHEDULED FOR REMOVAL ARE
 NOT SHOWN ON THIS PLAN. SEE SHEET
 C-1.

PROPOSED CELLCO PARTNERSHIP
 MONOPINE TOWER W/ GALVANIZED
 FLASH

4A
 C-1

PROPOSED CELLCO PARTNERSHIP
 DOUBLE 6' WIDE COMPOUND
 ACCESS GATES

6
 C-1

PROPOSED CELLCO PARTNERSHIP
 ICE BRIDGE AND ICE BRIDGE
 POSTS

1
 C-1

PROPOSED CELLCO PARTNERSHIP
 POWER AND TELCO UTILITY BACKBOARD

2
 C-1

PROPOSED CELLCO PARTNERSHIP
 PIPE BOLLARD, TYP.

3
 C-1

PROPOSED CELLCO PARTNERSHIP 12' WIDE
 CRUSHED STONE ACCESS DRIVE WITH A
 PROPOSED 20' WIDE ACCESS/UTILITY EASEMENT.

PROPOSED TRANSFORMER

PROPOSED CELLCO PARTNERSHIP
 12'X30' WIRELESS EQUIPMENT SHELTER
 WITH CONCRETE ENTRY STOOP. SEE
 SHEET C-3 FOR ELEVATIONS AND
 DETAILS.

PROPOSED GRADE LINE, TYP.

2
 C-1


PROPOSED CELLCO PARTNERSHIP
 CONCRETE AND CRUSHED STONE
 DRIVE. SEE SHEET C-1 FOR CONTINUATION.

4
 C-1

PROPOSED CELLCO PARTNERSHIP
 80' x 120' LEASE AREA

PROPOSED COMPOUND CHAIN
 LINK FENCE

1
 C-2
COMPOUND PLAN
 SCALE: 1"=15'-0"

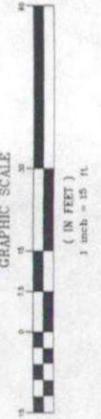

EXISTING GRADE CONTOUR LINE, TYP.

FUTURE WIRELESS CARRIER EQUIPMENT,
 TYP.

PROPOSED CELLCO PARTNERSHIP 55'x65'
 FENCED AND GRAVELLED COMPOUND

PROPOSED CELLCO PARTNERSHIP
 MONOPINE TOWER W/ GALVANIZED
 FLASH

4A
 C-1

PROPOSED CELLCO PARTNERSHIP
 DOUBLE 6' WIDE COMPOUND
 ACCESS GATES

6
 C-1

PROPOSED CELLCO PARTNERSHIP
 ICE BRIDGE AND ICE BRIDGE
 POSTS

1
 C-1

PROPOSED CELLCO PARTNERSHIP
 POWER AND TELCO UTILITY BACKBOARD

2
 C-1

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 PIPE BOLLARD, TYP.

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 C-1

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 WITH CONCRETE ENTRY STOOP. SEE
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 DETAILS.

PROPOSED GRADE LINE, TYP.

2
 C-1


PROPOSED CELLCO PARTNERSHIP
 CONCRETE AND CRUSHED STONE
 DRIVE. SEE SHEET C-1 FOR CONTINUATION.

4
 C-1

PROPOSED CELLCO PARTNERSHIP
 80' x 120' LEASE AREA

PROPOSED COMPOUND CHAIN
 LINK FENCE

1
 C-2
COMPOUND PLAN
 SCALE: 1"=15'-0"

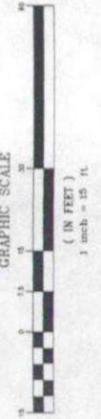

EXISTING GRADE CONTOUR LINE, TYP.

FUTURE WIRELESS CARRIER EQUIPMENT,
 TYP.


PROPOSED CELLCO PARTNERSHIP 55'x65'
 FENCED AND GRAVELLED COMPOUND

REVISIONS	
00	10/27/06 SITING COUNCIL REVIEW
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02	02/21/07 REVISED CT SITING COUNCIL
03	03/22/07 REVISED CT SITING COUNCIL

Cellco Partnership
d.b.a. **verizon** wireless

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Consulting Engineers, Project Management
Civil Structural Mechanical Electrical






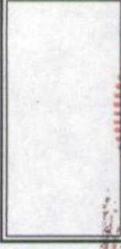


WASHINGTON NORTH
(UNDERWOOD PROPERTY)
"SITE 1"
MOUNTAIN ROAD
NEW PRESTON, CT 06777


PROJECT NO:	06068
DRAWN BY:	DMD
CHECKED BY:	CFC
SCALE:	AS NOTED
DATE:	06/19/06

COMPOUND
ELEVATIONS
(TOWER OPTIONS)


C-2A
DWG. 4 OF 8

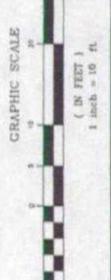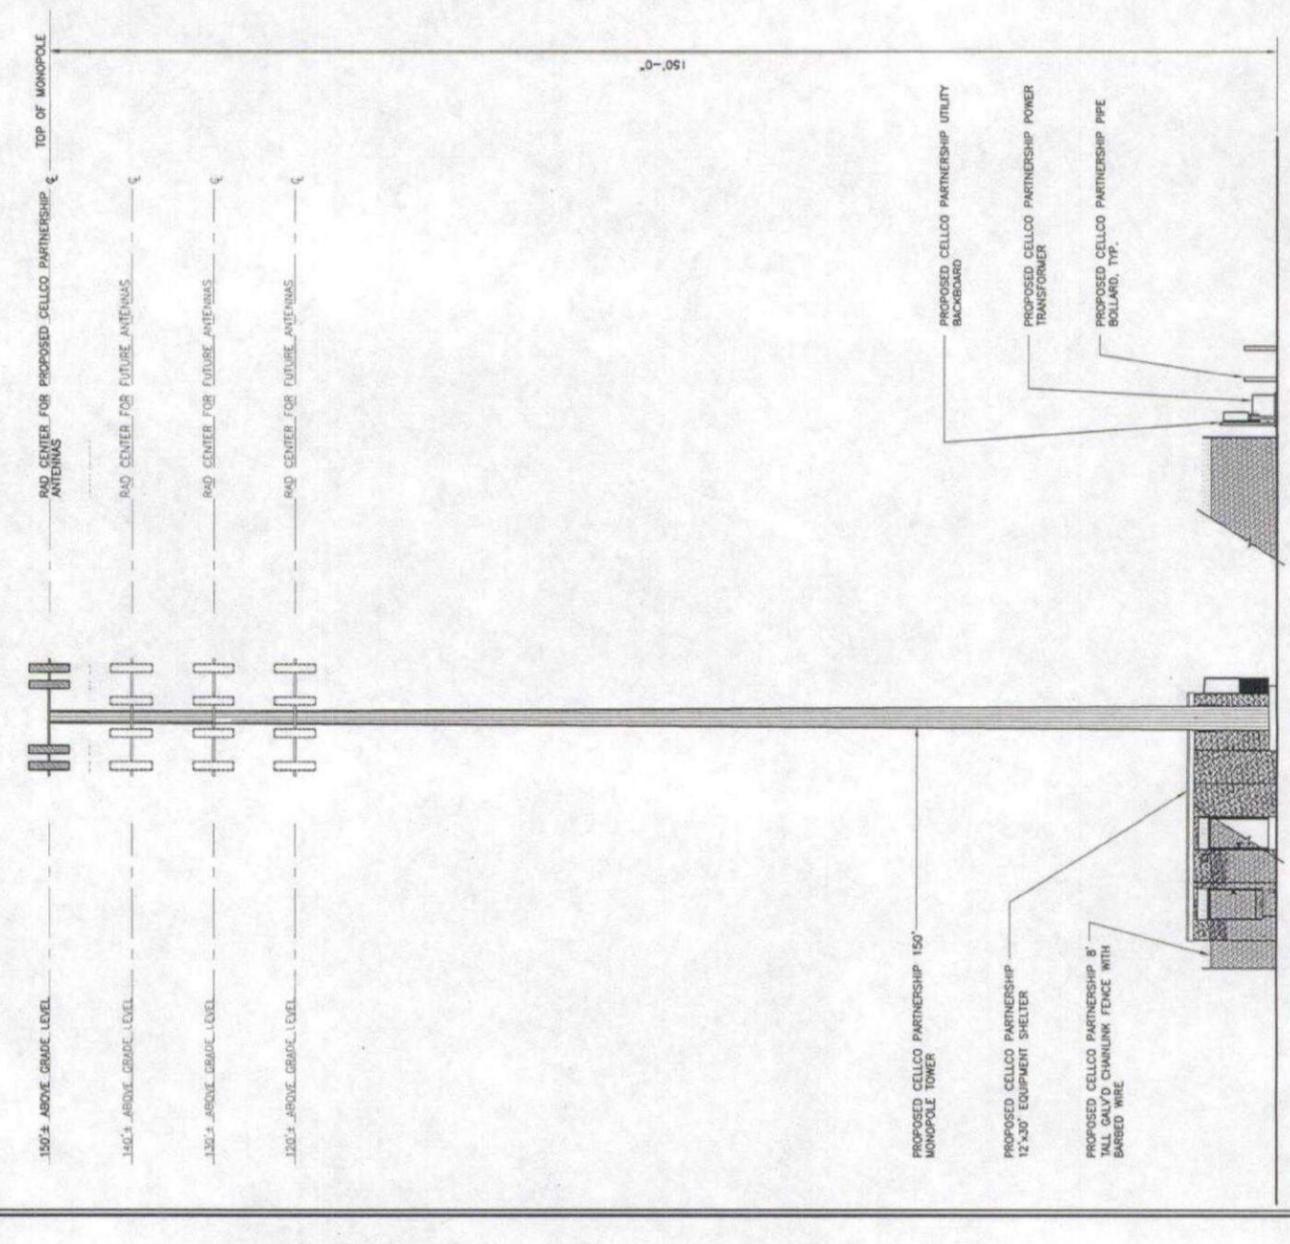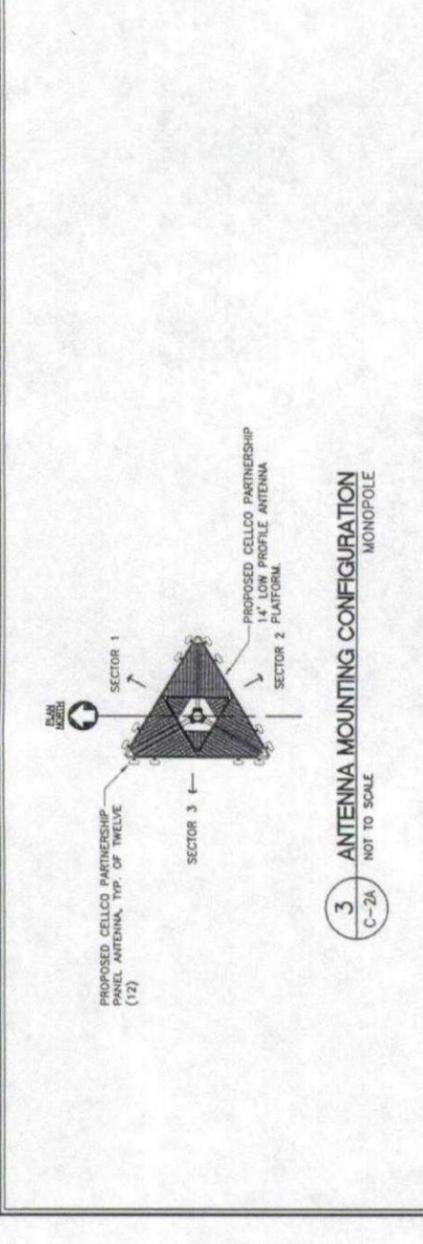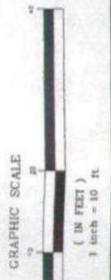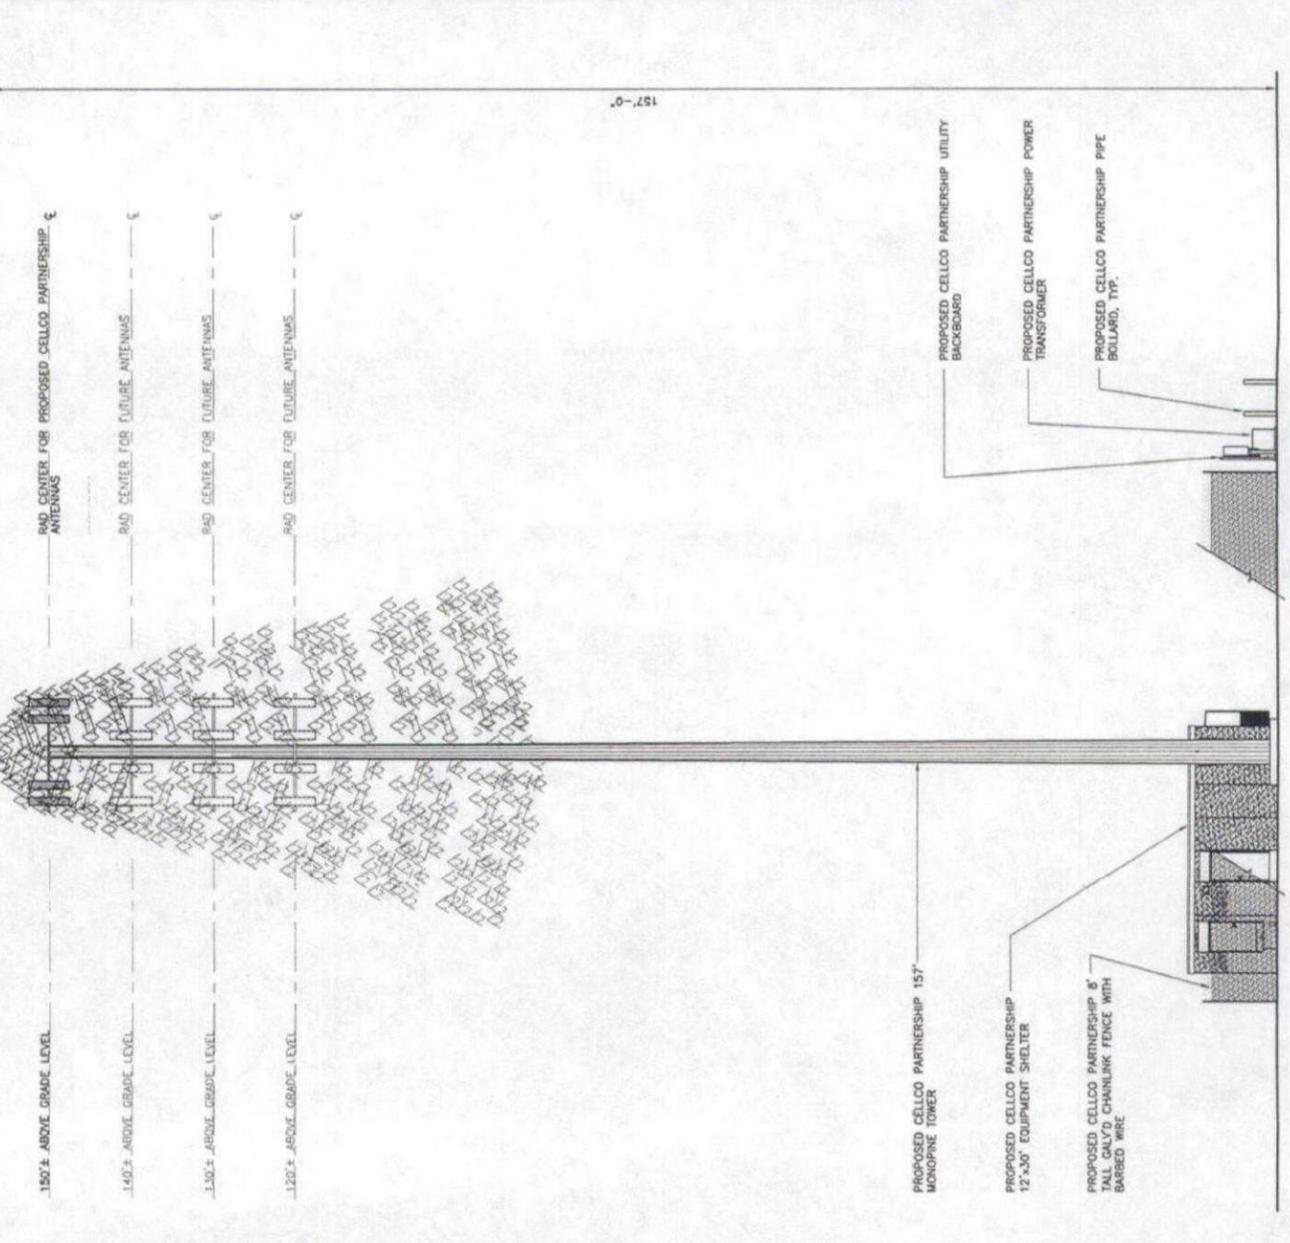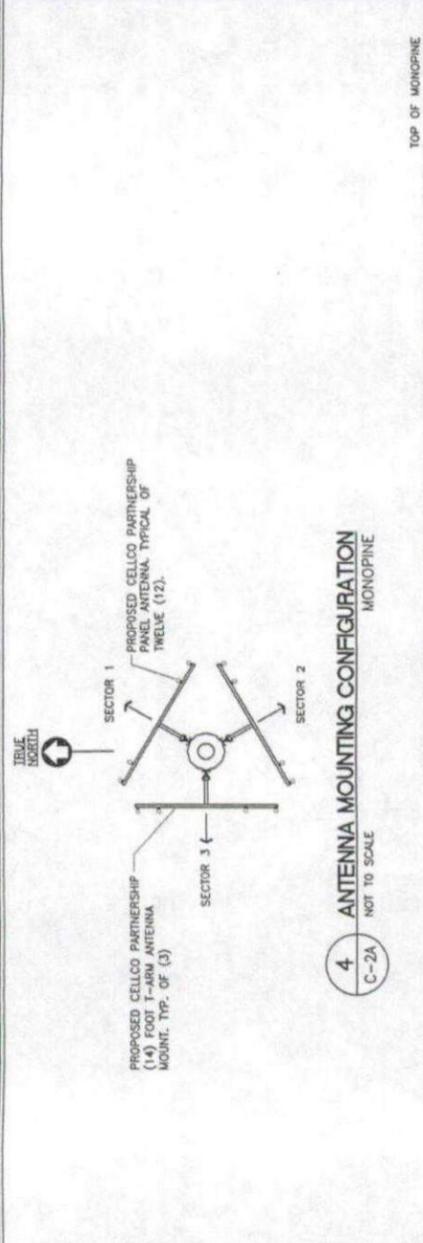

REVISIONS	
00	10/22/06 SITING COUNCIL REVIEW
01	01/09/07 CT SITING COUNCIL
02	02/27/07 REVISED CT SITING COUNCIL
03	03/22/07 REVISED CT SITING COUNCIL

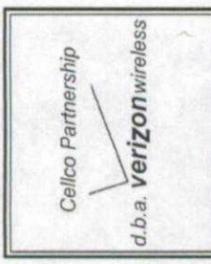

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 Civil Structural Mechanical Electrical

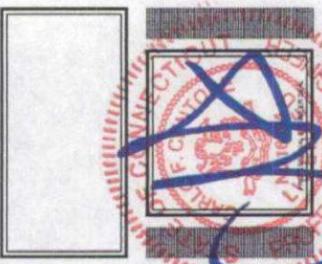

WASHINGTON NORTH
 (UNDERWOOD PROPERTY)
 SITE 1
 MOUNTAIN ROAD
 NEW PRESTON, CT 06717

PROJECT NO:	00008
DRAWN BY:	DMD
CHECKED BY:	CFC
SCALE:	AS NOTED
DATE:	08/19/06

**EROSION CONTROL
 DETAILS
 AND NOTES**

C-3
 DWG. 5 OF 8

EROSION CONTROL

GENERAL CONSTRUCTION SEQUENCE

THIS IS A GENERAL CONSTRUCTION SEQUENCE OUTLINE SOME ITEMS OF WHICH MAY NOT APPLY TO PARTICULAR SITES.


- 1) CUT AND STUMP AREAS OF PROPOSED CONSTRUCTION.
- 2) INSTALL TEMPORARY SEDIMENT AND EROSION CONTROL MEASURES AS REQUIRED.
- 3) REMOVE AND STOCKPILE TOPSOIL. STOCKPILE SHALL BE SEED TO PREVENT EROSION.
- 4) CONSTRUCT CLOSED DRAINAGE SYSTEM, PRECEPT CULVERT INLETS AND CATCH BASINS WITH SEDIMENTATION BARRIERS.
- 5) CONSTRUCT ROADWAYS AND PERFORM SITE GRADING, PLACING HAY BALES AND SITUATION FENCES AS REQUIRED TO CONTROL SOIL EROSION.
- 6) INSTALL UNDERGROUND UTILITIES.
- 7) BEGIN TEMPORARY AND PERMANENT SEEDING AND MULCHING. MULCHING SHALL BE SEEDING FOR MULCHED AREAS IMMEDIATELY AFTER THEIR CONSTRUCTION. NO AREA SHALL BE LEFT UNSTABILIZED FOR A TIME PERIOD OF MORE THAN 30 DAYS.
- 8) DAILY OR AS REQUIRED, CONSTRUCT, INSPECT AND, IF NECESSARY, RECONSTRUCT TEMPORARY BERMS, DRAINS, DITCHES, SILT FENCES AND SEDIMENT TRAPS INCLUDING MULCHING AND SEEDING.
- 9) BEGIN EXCAVATION FOR AND CONSTRUCTION OF TOWERS AND PLATFORMS.
- 10) FINISH PAVING ALL ROADWAYS, DRIVES, AND PARKING AREAS.
- 11) COMPLETE PERMANENT SEEDING AND LANDSCAPING.
- 12) NO FLOW SHALL BE DIVERTED TO ANY WETLANDS UNTIL A HEALTHY STAND OF GRASS HAS BEEN ESTABLISHED IN REPAIRED AREAS.
- 13) AFTER GRASS HAS BEEN FULLY GERMINATED IN ALL SEEDING AREAS, REMOVE ALL TEMPORARY EROSION CONTROL MEASURES.

CONSTRUCTION SPECIFICATIONS - SILT FENCE


- 1) THE GEOTEXTILE FABRIC SHALL MEET THE DESIGN CRITERIA FOR SILT FENCES.
- 2) THE FABRIC SHALL BE EMBEDDED A MINIMUM OF 8 INCHES INTO THE GROUND AND THE SOIL COMPACTED OVER THE EMBEDDED FABRIC.
- 3) WOVEN WIRE FENCE SHALL BE FASTENED SECURELY TO THE FENCE POSTS WITH WIRE TIES OR STAPLES.
- 4) FILTER CLOTH SHALL BE FASTENED SECURELY TO THE WOVEN WIRE FENCE WITH TIES SPACED EVERY 24 INCHES AT THE TOP, MID-SECTION AND BOTTOM.
- 5) WHEN TWO SECTIONS OF FILTER CLOTH ADJOIN EACH OTHER, THEY SHALL BE OVERLAPPED BY 6 INCHES, FOLDED, AND STAPLED.
- 6) FENCE POSTS SHALL BE A MINIMUM OF 36 INCHES LONG AND OWNEN A MINIMUM OF 4 INCHES AND THE GROUND WOOD POSTS SHALL BE OF SOUND QUALITY HARDWOOD AND SHALL HAVE A MINIMUM CROSS SECTIONAL AREA OF 3.0 SQUARE INCHES.
- 7) MAINTENANCE SHALL BE PERFORMED AS NEEDED TO PREVENT BUILD UP IN THE SILT FENCE DUE TO DEPOSITION OF SEDIMENT.

MAINTENANCE - SILT FENCE

- 1) SILT FENCES SHALL BE INSPECTED IMMEDIATELY AFTER EACH RAINFALL EVENT. ANY DAMAGE TO THE SILT FENCE OR RAINFALL, ANY REPAIRS THAT ARE REQUIRED SHALL BE MADE IMMEDIATELY.
- 2) IF THE FABRIC ON A SILT FENCE SHOULD DECOMPOSE OR BECOME INEFFECTIVE DURING THE EXPECTED LIFE OF THE FENCE, THE FABRIC SHALL BE REPLACED PROMPTLY.
- 3) SEDIMENT SHOULD BE INSPECTED AFTER EVERY STORM EVENT. THE DEPOSITS SHOULD BE REMOVED WHEN THEY REACHED APPROXIMATELY ONE-HALF THE HEIGHT OF THE BARRIER.
- 4) SEDIMENT DEPOSITS THAT ARE REMOVED OR LEFT IN PLACE AFTER THE FABRIC HAS BEEN REMOVED SHALL BE GRADED TO CONFORM WITH THE EXISTING TOPOGRAPHY AND VEGETATED.

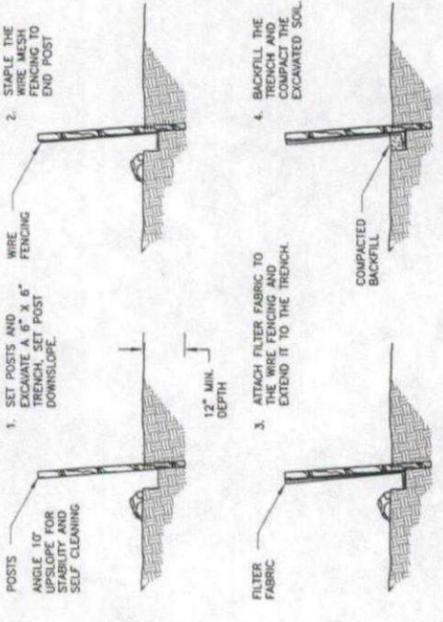

1 SEDIMENTATION CONTROL BARRIER-SILT FENCE
 NOT TO SCALE

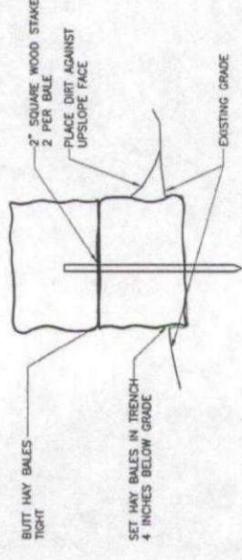

NOTE: A SECOND HAYBALE MAY BE REQUIRED WHERE SLOPE OR HEIGHT REQUIRES IT.

2 SECTION THRU HAYBALE EROSION CONTROL BARRIER
 NOT TO SCALE

TEMPORARY EROSION CONTROL MEASURES

- 1) DISTURBED AREAS SHALL BE KEPT TO THE MINIMUM AREA NECESSARY TO CONSTRUCT THE ROADWAYS AND ASSOCIATED DRAINAGE FACILITIES.
- 2) HAY BALE BARRIERS AND SEDIMENT TRAPS SHALL BE INSTALLED AS REQUIRED. BARRIERS AND TRAPS ARE TO BE MAINTAINED AND CLEANED UNTIL ALL SLOPES HAVE A HEALTHY STAND OF GRASS.
- 3) BALED HAY AND MULCH SHALL BE MOWING OF ASCRIBABLE. MULCH SHALL BE APPLIED TO ALL WOODS, WEEDS OR WOODY STEMS, AND SHALL BE DRY. NO SALT HAY SHALL BE USED.
- 4) FILL MATERIAL SHALL BE FREE FROM STUMPS, WOOD, ROOTS, ETC.
- 5) STOCKPILED MATERIALS SHALL BE PLACED ONLY IN AREAS SHOWN ON THE PLANS. STOCKPILES SHALL BE PROTECTED BY SLOTTATION FENCE AND SEED TO PREVENT EROSION. THESE MEASURES SHALL REMAIN UNTIL ALL MATERIAL HAS BEEN PLACED OR DISPOSED OFF SITE.
- 6) ALL DISTURBED AREAS SHALL BE LOAMED AND SEED. A MINIMUM OF 4 INCHES OF LOAM SHALL BE INSTALLED WITH NOT LESS THAN ONE POUND OF SEED PER 50 SQUARE YARDS OF AREA.
- 7) APPLICATION OF GRASS SEED, FERTILIZERS AND MULCH SHALL BE ACCOMPLISHED BY BROADCAST SEEDING OR HYDROSEEDING AT THE RATES OUTLINED BELOW:
 LIMESTONE: 75-100 LBS./1,000 SQUARE FEET.
 FERTILIZER: RATE RECOMMENDED BY MANUFACTURER.
 MULCH: HAY MULCH APPROXIMATELY 3 TONS/ACRE UNLESS EROSION CONTROL MATTING IS USED.
 SEED MIX (SLOPES LESS THAN 4:1)
 CHEERING RED RESCUE 20 LBS./ACRE
 RED TOP 2 42
 SLOPE MIX (SLOPES GREATER THAN 4:1)
 CHEERING RED RESCUE 20 LBS./ACRE
 TALL FESCUE 20
 BRISGS FOOT TREE FOL 48
- 8) AFTER ALL DISTURBED AREAS HAVE BEEN STABILIZED, THE TEMPORARY EROSION CONTROL MEASURES ARE TO BE REMOVED.
- 9) PAVED ROADWAYS MUST BE KEPT CLEAN AT ALL TIMES.
- 10) ALL CATCH BASIN INLETS WILL BE PROTECTED WITH LOW POINT SEDIMENTATION BARRIER.
- 11) ALL STORM DRAINAGE OUTLETS WILL BE STABILIZED AND CLEANED AS REQUIRED, BEFORE THE DISCHARGE POINTS BECOME OPERATIONAL.
- 12) ALL DEWATERING OPERATIONS MUST DISCHARGE DIRECTLY INTO A SEDIMENT FILTER AREA.
- 13) NO DISCHARGE SHALL BE DIRECTED TOWARDS ANY PROPOSED DITCHES, SWALES, OR PONDS UNTIL THEY HAVE BEEN PROPERLY STABILIZED.

CONSTRUCTION SPECIFICATIONS - STRAW OR HAY BALES

- 1) BALES SHALL BE PLACED IN A ROW WITH THE ENDS TIGHTLY ADJOINING.
- 2) EACH BALE SHALL BE EMBEDDED IN THE GROUND A MINIMUM OF 4 INCHES.
- 3) BALES SHALL BE ANCHORED IN PLACE BY AT LEAST TWO STAKES DRIVEN THROUGH THE BALE. THE STAKES SHALL BE DRIVEN AT LEAST 18 INCHES INTO THE GROUND.
- 4) BARRIERS SHALL BE INSPECTED AFTER EVERY RAINFALL AND PROMPTLY REPAIRED FOR REPLACEMENT AS NECESSARY.
- 5) BALES SHALL BE REMOVED WHEN NO LONGER NEEDED AND THE SEDIMENT COLLECTED SHALL BE DISPOSED OF PROPERLY.

MAINTENANCE - STRAW OR HAY BALES

- 1) STRAW OR HAY BALES SHALL BE INSPECTED IMMEDIATELY AFTER EACH RAINFALL AND AT LEAST DAILY DURING PROLONGED RAINFALL.
- 2) CLOSE ATTENTION SHALL BE PAID TO THE REPAIR OF DAMAGED BALES. ANY ACCUMULATING BENEATH THE BALES, AND FLOW AROUND THE END OF THE BALES.
- 3) NECESSARY REPAIRS OR REPLACEMENT OF BALES SHALL BE ACCOMPLISHED PROMPTLY.
- 4) SEDIMENT DEPOSITS SHOULD BE CHECKED AFTER EACH RAINFALL. THE DEPOSITS SHOULD BE REMOVED WHEN THE LEVEL OF DEPOSITION REACHES APPROXIMATELY ONE-HALF OF THE HEIGHT OF THE TABLE.
- 5) SEDIMENT DEPOSITS THAT ARE REMOVED OR LEFT IN PLACE AFTER THE BARRIER HAS BEEN DISMANTLED SHALL BE GRADED TO CONFORM WITH THE EXISTING TOPOGRAPHY AND VEGETATED USING

REVISIONS	
00	10/27/06 SITING COUNCIL REVIEW
01	8/19/07 CT SITING COUNCIL
02	02/27/07 REVISED CT SITING COUNCIL
03	03/22/07 REVISED CT SITING COUNCIL




WASHINGTON NORTH
(UNDERWOOD PROPERTY)
"SITE 1"
MOUNTAIN ROAD
NEW PRESTON, CT 06777


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DRAWN BY:	DMD
CHECKED BY:	CFC
SCALE:	AS NOTED
DATE:	06/19/06

SITE
DETAILS


C-4
DWG. 5 OF 8

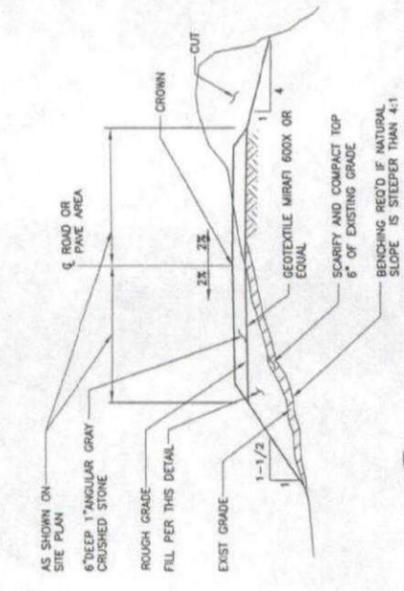

3 ACCESS DRIVE DETAIL
C-4 NOT TO SCALE

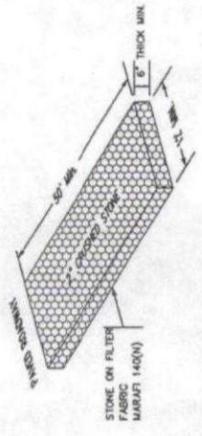


5 ANTI-TRACKING APRON
C-4 NOT TO SCALE

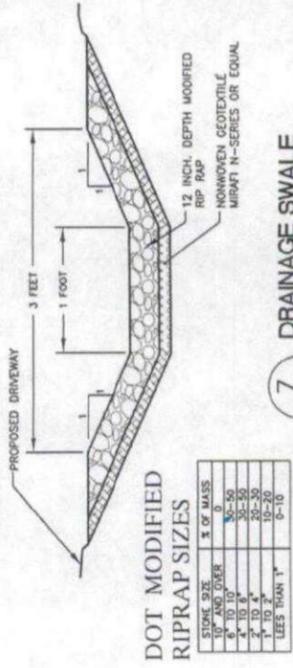


7 DRAINAGE SWALE
C-4 NOT TO SCALE

DOT MODIFIED RIPRAP SIZES


STONE SIZE	% OF MASS
4-10" OVER	5-10
4-10" 4"	30-50
4-10" 3"	25-30
4-10" 2"	10-15
4-10" 1"	5-10
LESS THAN 1"	0-10

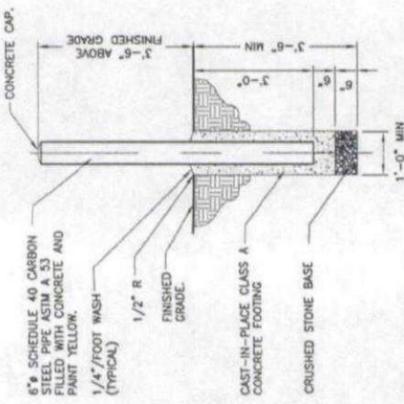


2 BOLLARD DETAIL
C-4 NOT TO SCALE

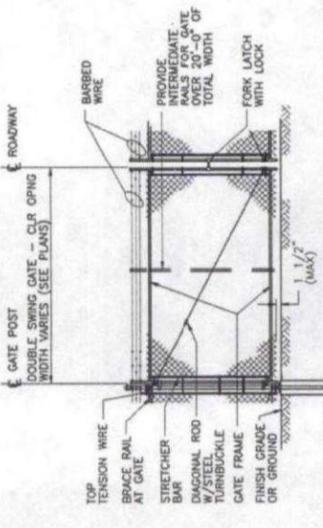


4A WOVEN WIRE SWING GATE-DOUBLE
C-4 NOT TO SCALE

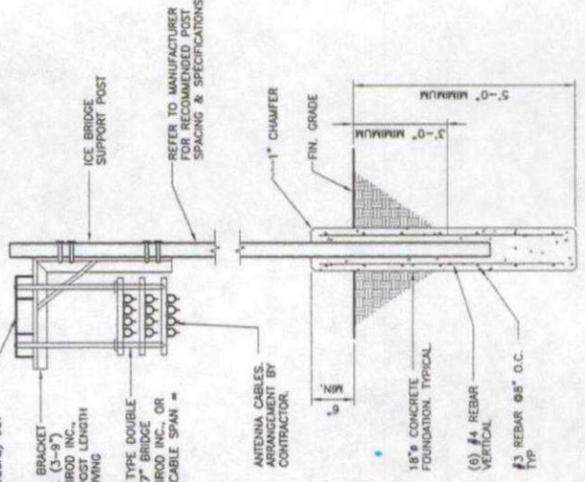

6 ICE BRIDGE DETAIL
C-4 NOT TO SCALE

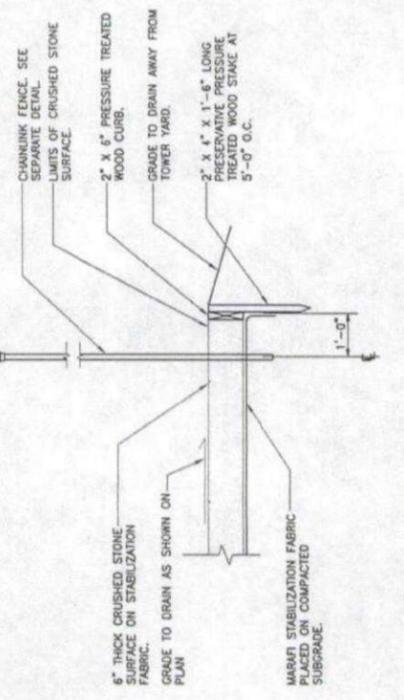

1 COMPOUND SURFACING DETAIL
C-4 NOT TO SCALE

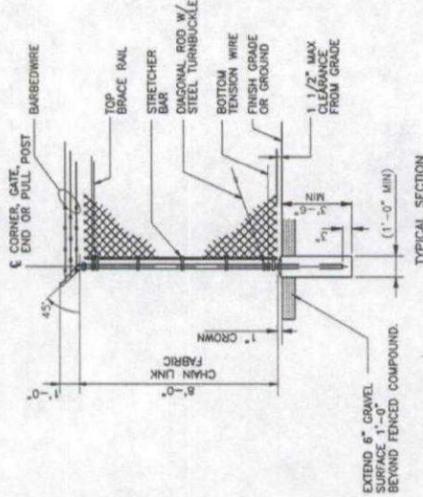

4 WOVEN WIRE FENCE DETAIL
C-4 NOT TO SCALE

WOVEN WIRE FENCE NOTES

- GATE POST, CORNER, TERMINAL OR PULL POST 2 1/2" # SCHEDULE 40 FOR GATE WIDTHS UP THRU 6 FEET OR 12 FEET FOR DOUBLE SWING GATE PER ASTM-F1083.
- LINE POST, 2" # SCHEDULE 40 PIPE PER ASTM-F1083.
- GATE FRAME: 1 1/2" # SCHEDULE 40 PIPE PER ASTM-F1083.
- TOP RAIL & BRACE RAIL: 1 1/2" # SCHEDULE 40 PIPE PER ASTM-F1083.
- FABRIC: 12 GA. CORE WIRE SIZE 2" MESH, CONFORMING TO ASTM-A392.
- THE WIRE MINIMUM 11 GA. GALVANIZED STEEL AT POSTS AND RAILS A SINGLE WRAP OF FABRIC TIE AND AT TENSION WIRE BY ROD RINGS SPACED MAX. 24" INTERVALS.
- TENSION WIRE: 7 GA. GALVANIZED STEEL.
- BARBED WIRE DOUBLE STRAND 12-1/2" O.D. TWISTED WIRE TO MATCH W/FIBRIC 14 GA., 4 FT. BARBS SPACED ON APPROXIMATELY 5" CENTERS.
- GATE LATCH: DROP DOWN LOCKABLE FORK LATCH AND LOCK, KEYED ALIKE FOR ALL SITES IN A GIVEN MTA.
- LOCAL ORDINANCE OF BARBED WIRE PERMIT REQUIREMENT SHALL BE COMPLIED WITH IF REQUIRED.
- HEIGHT = 6' VERTICAL + 1' BARBED WIRE VERTICAL DIMENSION.

27" ICE BRIDGE 3-0" CHANNEL #10" PART #124470 (PIROD INC. OR EQUAL) CUT TO LENGTH.

SUPPORT POST + BRACKET FOR 27" CHANNEL (3-9") PART #802225 (PIROD INC. OR EQUAL) POST LENGTH IN FIELD TO BE DETERMINED UNCAPPED END.

WANGER BRACKET TYPE DOUBLE CHANNEL #27" PART #802257 (PIROD INC. OR EQUAL) MAXIMUM CABLE SPAN = 3'-0" TYPICAL.

ANTENNA CABLES ARRANGEMENT BY CONTRACTOR.

18" CONCRETE FOUNDATION TYPICAL.
(6) #4 REBAR VERTICAL
(3) REBAR #5" O.C. TIP

NO.	DATE	REVISIONS
00	10/27/06	SITING COUNCIL REVIEW
01	01/09/07	CT SITING COUNCIL
02	02/23/07	REVISED CT SITING COUNCIL
03	03/23/07	REVISED CT SITING COUNCIL

Cellco Partnership
d.b.a. verizon wireless

NATCOMM
Naticom, LLC - Engineering Consultants
16, 2001 48-0208
16, 2001 48-0208
16, 2001 48-0208
Consulting Engineers, Project Management
Civil Structural Mechanical Electrical




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NEW PRESTON, CT 06777


PROJECT NO:	06068
DRAWN BY:	DMD
CHECKED BY:	CFC
SCALE:	AS NOTED
DATE:	06/19/06

SITE UTILITY
DETAILS AND
SHELTER ELEVATIONS


C-5
DWG. 7 OF 8

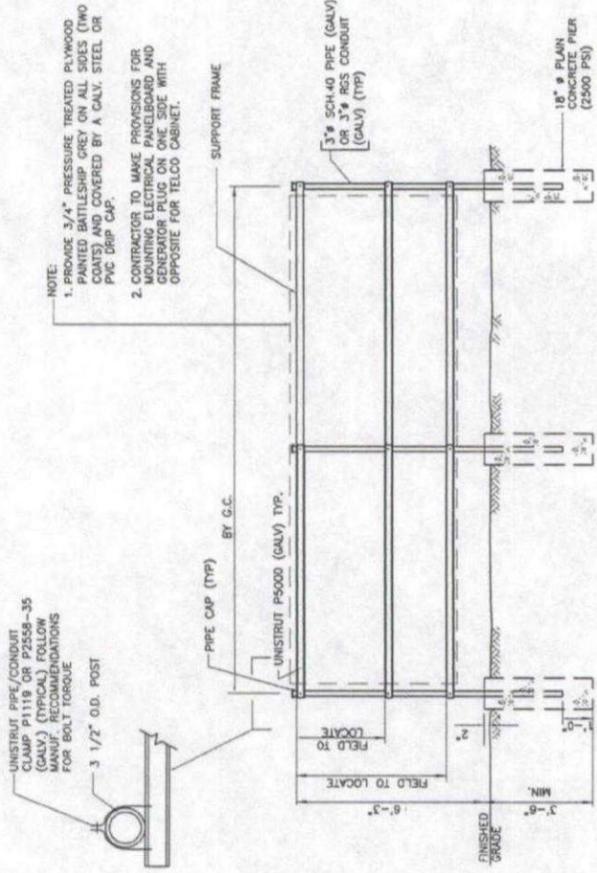


1 UTILITY SUPPORT FRAME (TYP)
NOT TO SCALE
C-5

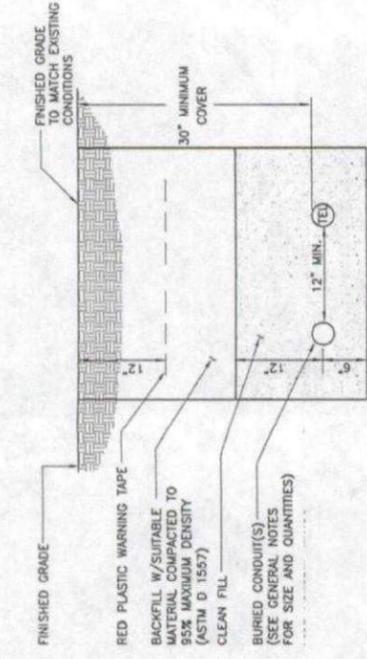


2 TYPICAL ELECTRICAL/TEL TRENCH DETAIL
NOT TO SCALE
C-5

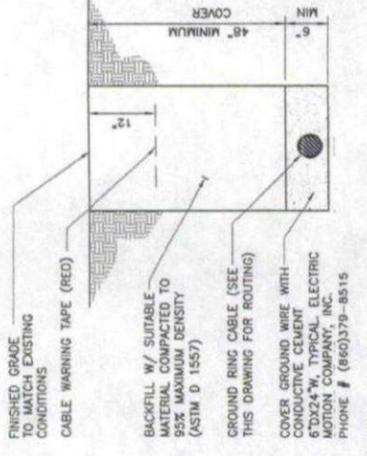


3 TYPICAL BURIAL GROUND CABLE DETAIL
NOT TO SCALE
C-5

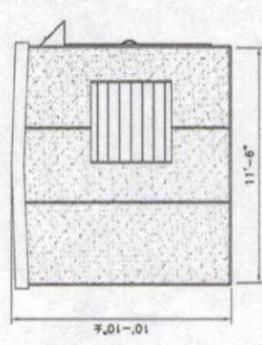


4 EAST SHELTER ELEVATION
SCALE: 1/4" = 1'-0"
C-5

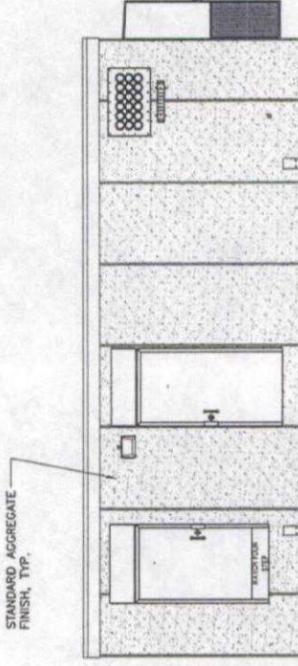


5 NORTH SHELTER ELEVATION
SCALE: 1/4" = 1'-0"
C-5

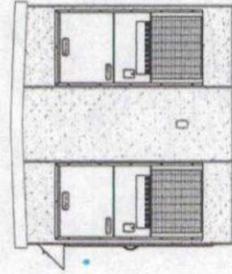

6 WEST SHELTER ELEVATION
SCALE: 1/4" = 1'-0"
C-5



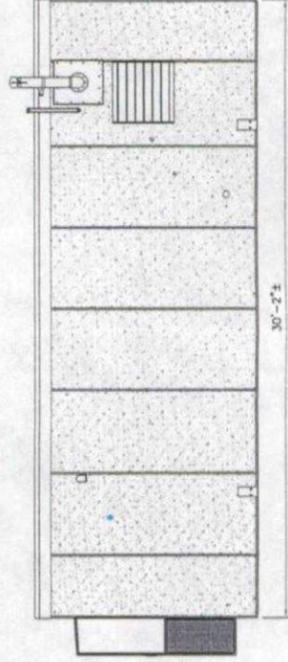


7 SOUTH SHELTER ELEVATION
SCALE: 1/4" = 1'-0"
C-5

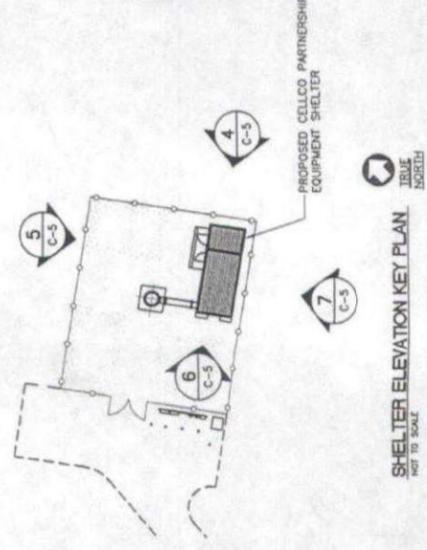

SHELTER ELEVATION KEY PLAN
NOT TO SCALE
C-5

REVISIONS	
00	10/27/08 SITING COUNCIL REVIEW
01	01/09/07 CT SITING COUNCIL
02	02/27/07 REVISED CT SITING COUNCIL
03	03/22/07 REVISED CT SITING COUNCIL

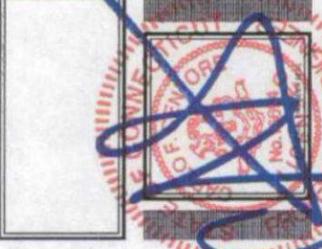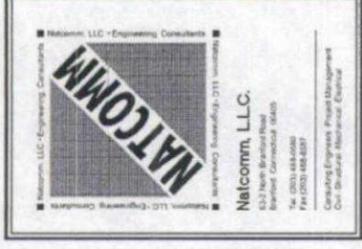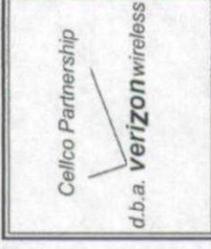

WASHINGTON NORTH
(UNDERWOOD PROPERTY)
"SITE 1"
MOUNTAIN ROAD
NEW PRESTON, CT 06777

PROJECT NO.	06058
DRAWN BY	DMD
CHECKED BY	CFC
SCALE	AS NOTED
DATE	06/19/06

**EQUIP. SHELTER
FOUNDATION
DETAILS AND NOTES**

C-6
DWG. 3 OF 8

GENERAL NOTES:

- GENERAL**
- IF ANY FIELD CONDITIONS EXIST WHICH PRECLUDE COMPLIANCE WITH THE DRAWINGS, THE CONTRACTOR SHALL IMMEDIATELY NOTIFY THE ENGINEER AND SHALL NOT PROCEED WITH ANY AFFECTED WORK.
 - DIMENSIONS AND DETAILS SHALL BE CHECKED AGAINST THE PRE MANUFACTURED EQUIPMENT BUILDING SHOP DRAWINGS.
 - THE CONTRACTOR SHALL VERIFY AND COORDINATE THE SIZE AND LOCATION OF ALL OPENINGS, SLEEVES AND ANCHOR BOLTS AS REQUIRED BY ALL TRADES.
 - REFER TO DRAWING T1 FOR ADDITIONAL NOTES AND REQUIREMENTS.

COMPACTED GRAVEL FILL





- COMPACTED GRAVEL FILL SHALL BE FURNISHED AND PLACED AS A FOUNDATION FOR STRUCTURES, WHERE SHOWN ON THE CONTRACT DRAWINGS OR DIRECTED BY THE ENGINEER. GRAVEL SHALL CONFORM TO THE REQUIREMENTS OF ARTICLE M.02.02 OF THE STANDARD SPECIFICATIONS. ADMIXTURES AND SURFACE PROTECTIVE MATERIALS USED TO PREVENT THE GRAVEL FROM FREEZING MUST MEET THE APPROVAL OF THE ENGINEER. THE LARGEST SIZE SHALL BE 3-1/2 INCHES.
- SAMPLES OF THE MATERIAL TO BE USED SHALL BE DELIVERED TO THE JOB SITE 5 DAYS PRIOR TO ITS INTENDED USE SO IT MAY BE TESTED FOR APPROVAL.
- AFTER ALL EXCAVATION HAS BEEN COMPLETED, GRAVEL SHALL BE DEPOSITED IN LAYERS NOT EXCEEDING EIGHT (8) INCHES IN DEPTH OVER THE AREA OF EXCAVATION. LAYERS SHALL BE LEVELED OFF BY THE USE OF BLADE GRADERS OR BUILDING GRADERS WITH ADOQUATE POWER FOR THE WORK INVOLVED. THE ENTIRE AREA OF EACH LAYER SHALL BE COMPACTED BY USE OF APPROVED VIBRATORY, PNEUMATIC-TIRED OR TREAD-TYPE COMPACTOR EQUIPMENT. COMPACTOR SHALL BE CONSIDERED TO BE THE MAXIMUM DRY DENSITY ACHIEVED BY ASTM 1-98 METHOD C. THE MOISTURE CONTENT OF THE GRAVEL SHALL NOT VARY BY MORE THAN 3% FROM ITS OPTIMUM MOISTURE CONTENT. NO SUBSEQUENT LAYER SHALL BE DEPOSITED UNTIL THE SPECIFIED COMPACTION IS ACHIEVED FOR THE PREVIOUS LAYER. IF NECESSARY TO OBTAIN THE REQUIRED COMPACTION, WATER SHALL BE APPLIED TO THE GRAVEL. GRAVEL SHALL BE PROTECTED FROM FREEZING BY USE OF APPROVED PROTECTIVE MATERIALS ON THE SURFACE, OR BOTH.

FOUNDATIONS


- ALL FOOTINGS SHALL BEAR ON UNDISTURBED NATURAL MATERIAL OR COMPACTED STRUCTURAL FILL HAVING AN ALLOWABLE BEARING CAPACITY 2 TONS PER SQUARE FOOT TOTAL LOAD PRESSURE.
- ELEVATIONS OF BOTTOM OF FOOTING SHOWN ON THE PLANS ARE FOR BIDDING PURPOSES AND SHALL BE LOWBID TO THE REQUIRED BEARING MATERIAL AS SHOWN ON THE PLANS. CONTRACTOR SHALL VERIFY THE BEARING MATERIAL ENCOUNTERED AT THE NOTED ELEVATIONS, NOTIFY THE ENGINEER IMMEDIATELY.

CONCRETE

- ALL CONCRETE WORK SHALL CONFORM TO THE AMERICAN CONCRETE INSTITUTE "SPECIFICATIONS FOR STRUCTURAL CONCRETE FOR BUILDINGS" (ACI 301).
- ALL CONCRETE WORK IS DESIGNED BY ULTIMATE STRENGTH METHODS AND SHALL BE NORMAL WEIGHT WITH A 28 DAY COMPRESSIVE STRENGTH OF 3000 PSI.
- ALL REINFORCING STEEL SHALL BE HIGH STRENGTH DEFORMED BARS CONFORMING TO ASTM A615 - GRADE 60.
- ALL DETAILING, FABRICATION AND PLACING OF REINFORCING BARS SHALL BE IN ACCORDANCE WITH THE LATEST ACI MANUAL OF STANDARD PRACTICE FOR DETAILING REINFORCEMENT IN CONCRETE STRUCTURES (ACI 315).
- WELDED WIRE FABRIC SHALL CONFORM TO ASTM A-185. WIRE MESH REINFORCEMENT MUST LAP ONE FULL MESH AT SOE AND END LAPS, AND SHALL BE WIRED TOGETHER. MESH SHALL EXTEND WITHIN 2" OF SLAB EDGES.
- LOCATE WELDED WIRE FABRIC ONE THIRD THE SLAB THICKNESS BELOW THE TOP SURFACE. MAINTAIN LOCATION OF STEEL DURING POUR. SUPPORT MESH ON CHAIRS, BOLSTERS, OR SMALL BRICK OR STONE, NOT ON WOOD OR OTHER ORGANIC MATERIALS.
- SHOP DRAWINGS AND CONCRETE ADMIXTURE PRODUCT DATA SHALL BE SUBMITTED TO THE ENGINEER FOR APPROVAL PRIOR TO COMMENCING CONSTRUCTION. DRAWINGS SHALL BE PROVIDED FOR SLABS-ON-GRADE AND CAST-IN-PLACE WALLS. ALL PERTINENT DIMENSIONS, REINFORCEMENT SIZES, SPACING, LOCATIONS AND QUANTITIES SHALL BE NOTED.

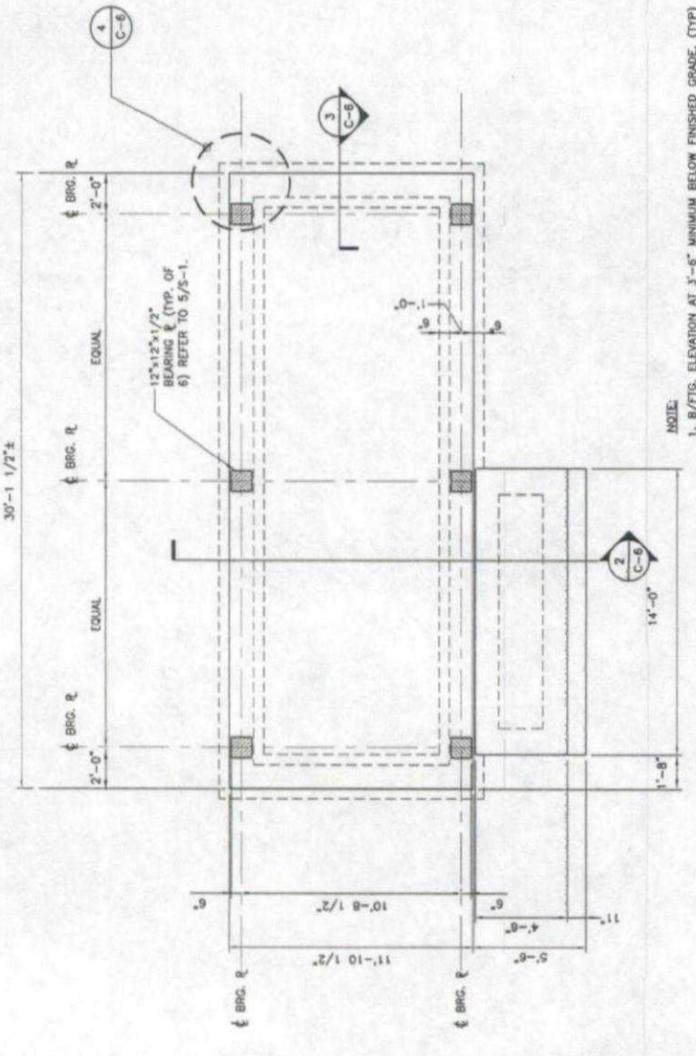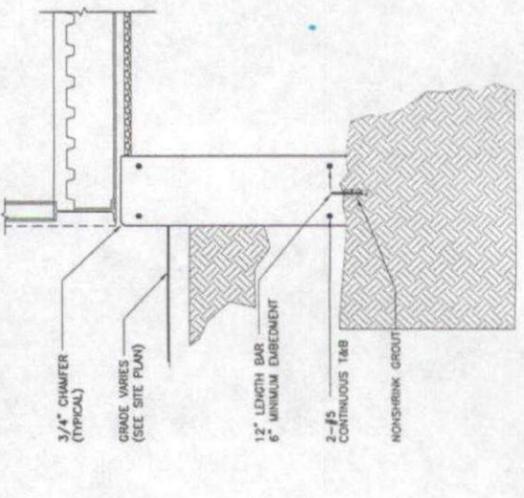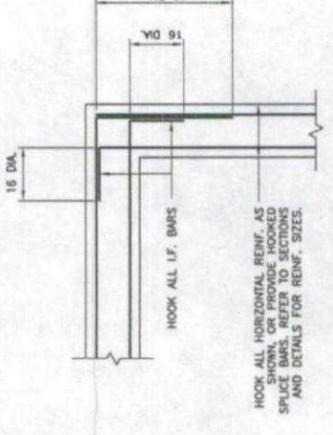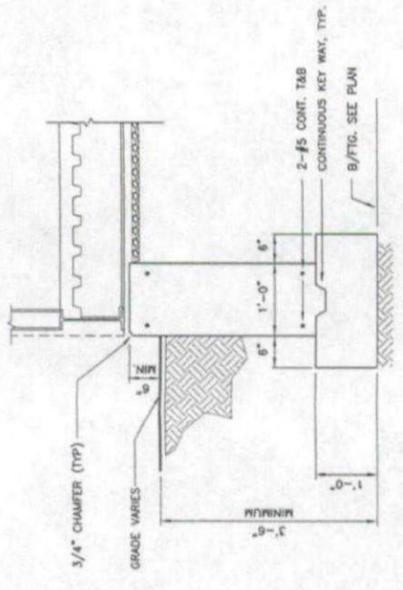

EQUIPMENT SHELTER BY VERIZON WIRELESS. VERIFY ALL SHELTER DIMENSIONS, EQUIPMENT DIMENSIONS, EQUIPMENT LOCATIONS AND UTILITY OPENINGS WITH BUILDING SHOP DRAWINGS PRIOR TO COMMENCEMENT OF WORK.

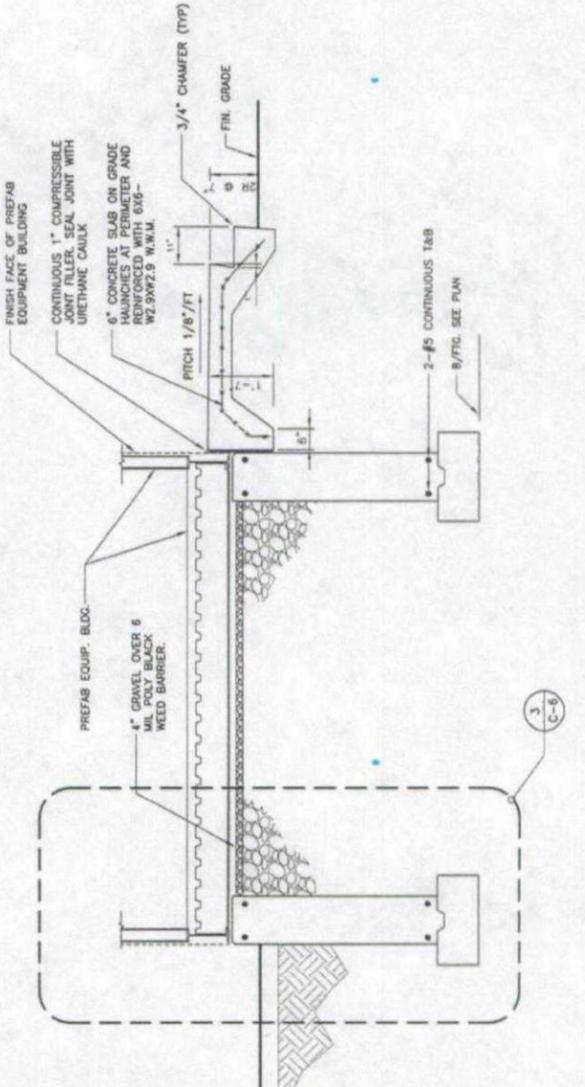

6 FOUNDATION OVER LEDGE (TYPICAL)
SCALE: 3/4"=1'-0"